

DATE OF MEETING [March 18, 2019]

AUTHORED BY [MADELEINE KOCH, PLANNER, CURRENT PLANNING]

SUBJECT [DEVELOPMENT PERMIT APPLICATION NO. DP1115 –  
615 & 699 HAREWOOD ROAD]

## OVERVIEW

### **Purpose of Report**

[To present for Council’s consideration, a development permit application for a multiple-dwelling residential development, located at 615 and 699 Harewood Road. ]

### **Recommendation**

[That Council issue Development Permit No. DP1115 at 615 and 699 Harewood Road with the following variances:

- increase the maximum allowable height from 8m to 8.89m for Building A and 8.84m for Building B;
- reduce the minimum rear yard setback from 1.5m to 1.2m for proposed Lot A;
- reduce the required number of parking spaces for proposed Lot A from 8 spaces to 4;
- increase the maximum permitted percentage of small car spaces from 40% to 50% for proposed Lot B. ]

## BACKGROUND

[A development permit application, DP1115, was received for 619 and 699 Harewood Road from Michele Hayden on behalf of 1035137 BC Ltd. The applicant proposes to construct a multiple-family development consisting of two fourplexes within the subject properties.

In 2016, an application was made to rezone the subject properties from R1 (Single Dwelling Residential) to R6 (Townhouse Residential) in order to permit construction of an 11-unit townhouse development. The application was denied at third reading. The applicant subsequently reduced the number of proposed units from 11 to 8 and submitted a new rezoning application (RA380) to rezone the properties from R1 to R5 (Three and Four Unit Residential). In 2017, the subject property was successfully rezoned in order to permit a fourplex on each lot, for a total of 8 units. The proposal is consistent with the density envisioned at the time of rezoning approval.

### **Subject Property**

<i>Zoning</i>	R5 – Three and Four Unit Residential
<i>Location</i>	The southeast corner of the intersection at Harewood Road and Wakesiah Avenue.
<i>Total Combined Lot Area</i>	2,348.9 m <sup>2</sup> (615 Wakesiah Avenue: 333m <sup>2</sup> ) (699 Wakesiah Avenue: 2,015m <sup>2</sup> )

<i>Official Community Plan (OCP)</i>	Map 1 – Future Land Use Plan – Neighbourhood; Map 3 – Development Permit Areas- Development Permit Area No. 9 - Commercial, Industrial, Institutional, Multiple Family and Mixed Commercial/Residential development.
<i>Relevant Design Guidelines</i>	General Development Permit Area Design Guidelines; Harewood Neighbourhood Plan – Urban Design Framework & Guidelines

### *Site Context*

The subject properties are located directly across from Colliery Dam Park to the west and the Department of National Defence lands to the northwest. Vancouver Island University is located one block to the north and University Village Mall is approximately 700m to the northwest. The nearest bus stop is located 250m to the north on Fifth Street.

Single Dwelling Residential (R1) lots border the subject properties to the south and west with some townhouses and duplexes located nearby. The house on the adjacent lot to the south at 624 Wakesiah Avenue is included on the City of Nanaimo’s heritage register.

Two houses are located on 699 Harewood Road, and 615 Harewood Road is a narrow undersized parcel that is currently vacant. The properties are located on a laneway, which provides site access. A number of mature trees are located within the lots and within the adjacent City road right-of-way.

## **DISCUSSION**

### **Proposed Development**

The proposed development is two fourplexes, with one on each of the two subject properties. A boundary adjustment is proposed to facilitate development on each lot, and will be required as a condition of development permit approval. Shared parking, access, and amenities will also be secured through the development permit.

### *Site Design*

Each fourplex is located in close proximity to the road frontages and incorporates a strong street presence with individual unit patios and entrances from the street. Additional onsite walkways and a common greenspace are proposed between the two buildings at the corner of Wakesiah Avenue and Harewood Road, and a shared structure to accommodate bicycle and waste disposal bin storage is proposed to be located nearby. Site parking is accessible from the laneway at the rear of the site.

### *Building Design*

Each building contains four two-storey townhouses, with each unit having three bedrooms. The front of each unit features a small balcony, a ground-level patio, and a slightly stepped back entrance. The rear of each unit features a porch and a back door with connections to the onsite walkways.

### *Landscape Design*

The landscape plan features a common amenity space with an arbor entry, seating, and bollard lighting. The landscape plan features retention of one existing Douglas fir tree, two raingardens, and a planting mix of native and drought-tolerant species.

### **Design Advisory Panel Recommendations**

At its meeting held on on 2018-NOV-08, the Design Advisory Panel (DAP) accepted DP001115 as presented and provided the following recommendations:

- Look at ways to break the massing of Buildings A and B by adding windows to the upper portion of the walls facing the park area;
- Suggest that the tree protection area be maintained;
- Consider ways to bring Colliery Dam Park details into the overall design of the development;
- Consider opening up parking areas to avoid sharp corners;
- Reconsider use of Heavenly Bamboo in the planting material;
- Consider ways to improve the pedestrian connection to Colliery Dam trailway.

The applicant has made alterations to the building and landscape design plans to address the Design Panel's recommendations.

### **Proposed Variances**

#### *Building Height*

The maximum permitted building height applicable to this development is 8m. A maximum height of 8.89m is proposed for Building A (a variance of 0.89m) and a maximum height of 0.84m is proposed for Building B (a variance of 0.84m).

Each unit in Building A and Building B steps down slightly with the slope of the site, which increases the overall height of the buildings. The variance is only necessary for the pitched portions of the shed roofs, which add architectural interest.

#### *Rear Yard Setback*

The minimum rear yard setback is 1.5 metres. A rear yard setback of 1.2m is proposed for Lot A; a variance of 0.3m.

This setback is proposed to accommodate a shared structure used to store bicycles and curbside waste disposal bins centrally located between the two buildings.

#### *Required Parking*

The required parking for Lot A is 8 spaces. The applicant proposes 4 spaces; a variance of 4 spaces.

Three of the required spaces will be provided within Lot B as small car spaces, for a total of 7 parking spaces allocated to Lot A. Functionally, the shared parking arrangement will support a unified site design across the two properties.

It should be noted that the total parking space requirement for this development is 16 spaces across the two lots, and a total of 15 are proposed. This application was received when the former parking bylaw was still in place and as such, the original parking plan was designed to comply with the former parking requirement of 12 spaces across the two lots. To accommodate the new “Off-Street Parking Regulations Bylaw 2018 No. 7266”, the applicants have reconfigured the site plan to maximize parking within the development while maintaining adequate space for outdoor amenities and stormwater management.

The applicant considered reducing the number of bedrooms per unit to reduce the parking requirement; however, this would limit the development’s ability to provide family-oriented housing, which is a known community need in this area.

In addition, on-street parking is available on both Harewood Road and Wakesiah Avenue.

#### *Small Car Parking*

The maximum permitted amount of small car parking spaces is 40% of all required parking spaces. 50% of the required parking spaces for Lot B are proposed to be small car parking spaces; a variance of 10%.

To accommodate 8 parking spaces for Lot B without compromising the proposed rain garden, an additional small car parking space is proposed for Lot B. The requested variance is for 50% small car parking spaces for Lot B. A total of 43.8% of the total required parking for the two lots is proposed as small car spaces.

Staff recommend approval of the development permit application and variances.

See Attachment for more information.

#### **SUMMARY POINTS**

- A development permit application has been received to allow construction of two fourplexes at 699 and 615 Harewood Road.
- A boundary adjustment will be needed to support the proposed development.
- The proposed variances are requested to support a unified site design across the two subject properties

## **ATTACHMENTS**

ATTACHMENT A: Permit Terms and Conditions  
ATTACHMENT B: Location Plan  
ATTACHMENT C: Site Plan  
ATTACHMENT D: Building Elevations  
ATTACHMENT E: Landscape Plan and Details  
ATTACHMENT F: Streetscapes  
ATTACHMENT G: Aerial Photo |

### **Submitted by:**

L. Rowett  
Manager, Current Planning |

### **Concurrence by:**

D. Lindsay  
Director, Community Development |

**ATTACHMENT A**  
**PERMIT TERMS AND CONDITIONS**

**TERMS OF PERMIT**

The City of Nanaimo “ZONING BYLAW 2011 NO. 4500” is varied as follows:

1. *Section 7.6.1 – to increase the maximum allowable building height from 8m to:  
i. 8.89m (Building A)  
ii. 8.84m (Building B)*
2. *Section 7.5.1 – to reduce the minimum rear setback from 1.5m to 1.2m for proposed Lot A.*


The City of Nanaimo “OFF-STREET PARKING REGULATIONS BYLAW 2018 NO. 7266” is varied as follows:

1. *Section 7.1 Multiple Family Dwelling Parking Requirements – to reduce the required number of parking spaces for Lot A from 8 spaces to 4 spaces.*
2. *Section 4.3 Small Car Spaces – to increase the permitted percentage of small car parking spaces for Lot B from 40% to 50%.*

**CONDITIONS OF PERMIT**

1. Prior to building permit issuance, a boundary adjustment between the subject properties is required in accordance with the Site Plan prepared by de Hoog & Kierulf Architects, dated 2019-FEB-28 as shown on Attachment C.
2. The subject properties are developed in accordance with the Site Plan prepared by de Hoog & Kierulf Architects, dated 2019-FEB-28 as shown on Attachment C.
3. The subject properties are developed in substantial compliance with the Building Elevations prepared by de Hoog & Kierulf Architects, dated 2019-FEB-28 as shown on Attachment D.
4. The subject properties are developed in substantial compliance with the Landscape Plan prepared by MacDonald Gray., dated 2019-FEB-27 as shown on Attachment E.
5. Prior to building occupancy, registration of a Section 219 covenant containing an easement to secure reciprocal access and parking between the subject properties.

ATTACHMENT B  
LOCATION PLAN

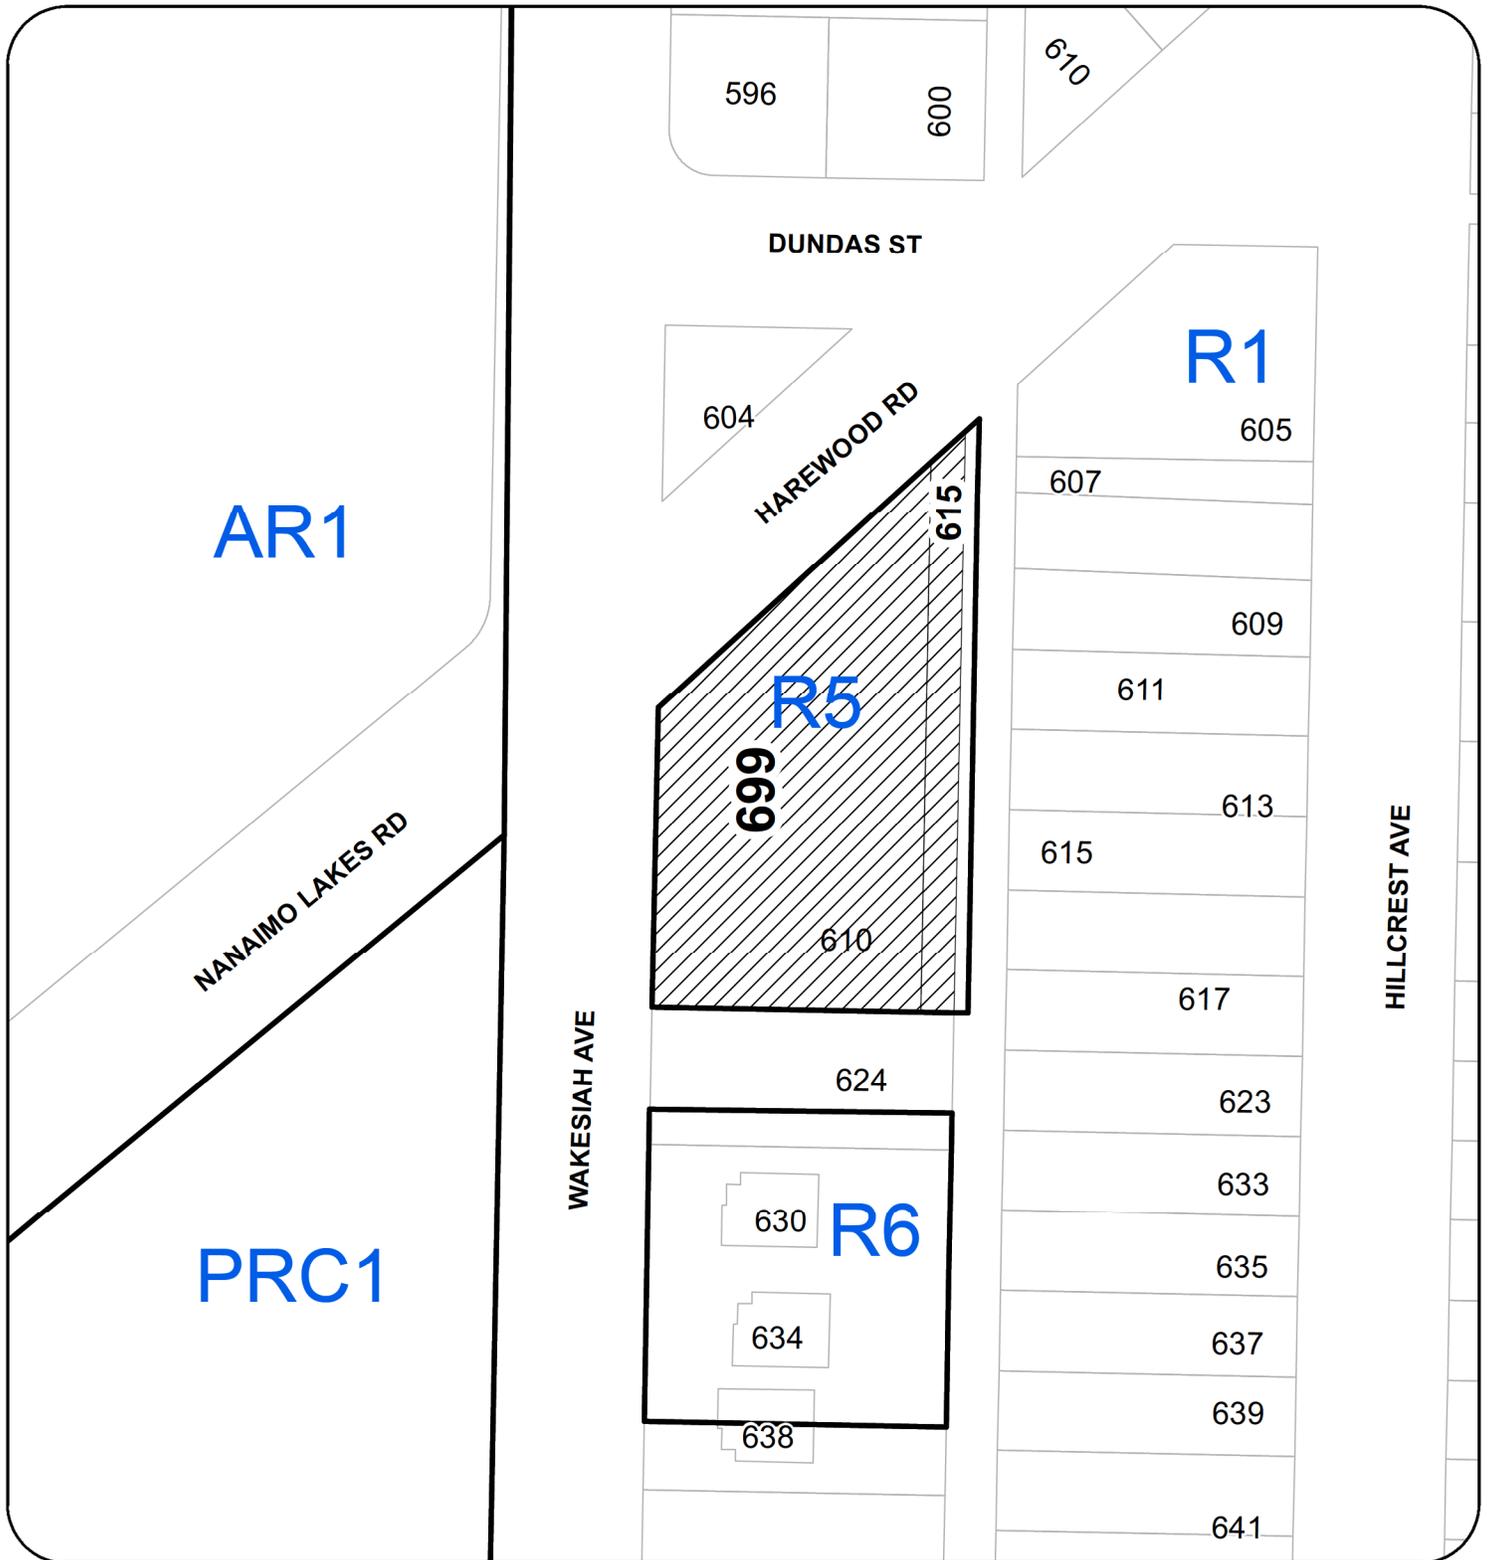

DEVELOPMENT PERMIT NO. DP001115


LOCATION PLAN



 Subject Property

Civic: 615 Harewood Road / 699 Harewood Road  
Legal Description: LOT B PLAN 1566 EXCEPT PART IN PLAN EPP77798  
AND SECTION 22 RANGE 5, PLAN 630 EXCEPT THOSE PARTS IN PLANS  
1566 AND 1575 ALL IN SECTION 1 NANAIMO DISTRICT

# ATTACHMENT C SITE PLAN

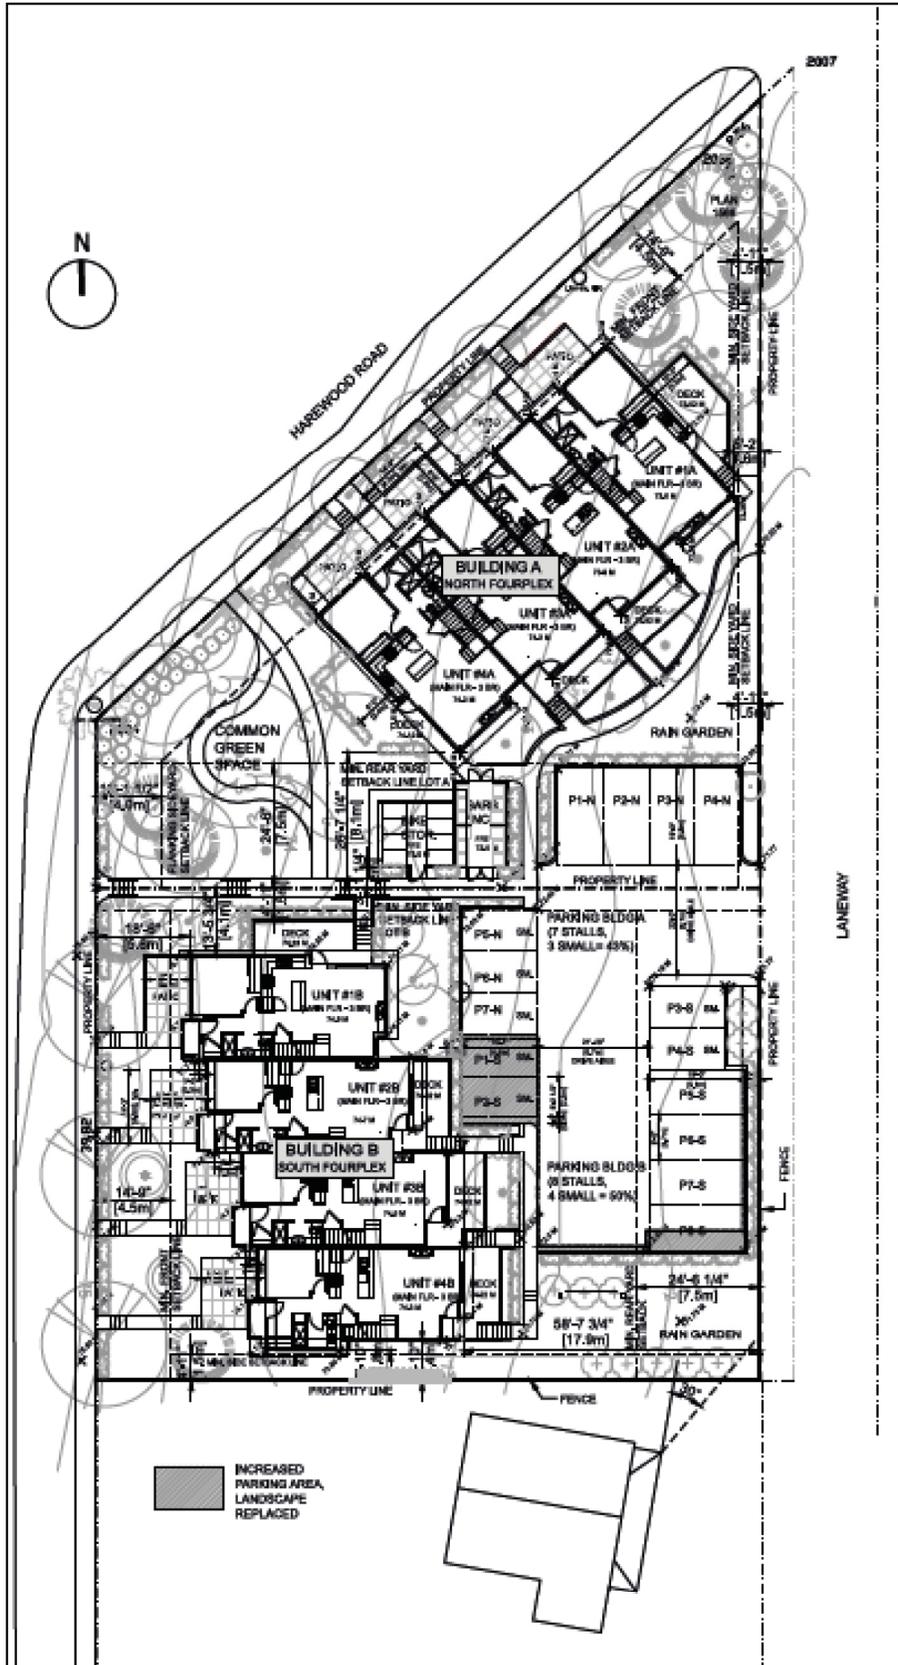

SITE PLAN: MAIN LEVEL  
SCALE: 1/16" = 1'-0"

RECEIVED  
DP 1116  
2019-FEB-28  
Current Planning

REVISED FOR DP  
28 FEBRUARY 2019  
SUBMITTED FOR DP  
07 SEPTEMBER 2018

615 + 699 HAREWOOD ROAD, NANAIMO, BC  
SITE PLAN

SK-3  
1/16" = 1'-0"

de Hoog & Kleruff architects

# ATTACHMENT D BUILDING ELEVATIONS




BUILDING A - WEST ELEVATION (NORTHWEST)  
(FRONT FACING HAREWOOD ROAD)



BUILDING A - EAST (SOUTHEAST) ELEVATION  
(REAR FACING RAIN GARDEN + PARKING)



BUILDING A - SOUTH ELEVATION  
(SIDE FACING COMMON GREEN SPACE)

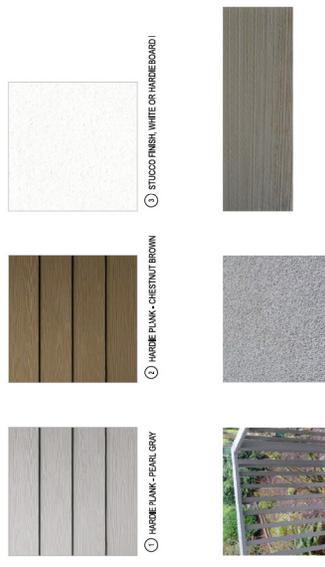

- ① HARRIE PLANK - PEARL GRAY
- ② HARRIE PLANK - CHESTNUT BROWN
- ③ STUDCO FINISH, WHITE OR HARDEBOARD
- ④ COMB FACE WOOD FASCIA - BANDING, PTD. - 812 CLOVERDALE
- ⑤ COMB FACE WOOD DOOR + WINDOW TRIM, PTD. - 812 CLOVERDALE
- ⑥ COMB FACE CLAD POSTS + BEAMS, PTD. - 812 CLOVERDALE
- ⑦ GUARD RAIL WITH PRE-FINISHED METAL
- ⑧ 2-PLY SSS ROOFING - CHARCOAL GREY



- ⑨ VINYL WINDOWS - CHARCOAL EXTERIOR, WHITE INTERIOR
- ⑩ FIBREGASS DOOR W/ SIDE LITE - PTD. TO MATCH WINDOWS
- ⑪ FIBREGASS DOOR W/ FULL LITE - PTD. TO MATCH WINDOWS
- ⑫ METAL SOFFIT - WOOD-GRAIN VALNUT OR BROWN TO MATCH CLADDING
- ⑬ 2-PLY SSS ROOFING - CHARCOAL GREY
- ⑭ WOOD SCREENS + TRELLISES - 811 CLOVERDALE

**FINISHES LEGEND**

- ① HARRIE PLANK - PEARL GRAY
- ② HARRIE PLANK - CHESTNUT BROWN
- ③ STUDCO FINISH, WHITE OR HARDEBOARD IN ARCTIC WHITE
- ④ COMB FACE WOOD FASCIA - BANDING, PTD. - 812 CLOVERDALE
- ⑤ COMB FACE WOOD DOOR + WINDOW TRIM, PTD. - 812 CLOVERDALE
- ⑥ COMB FACE CLAD POSTS + BEAMS, PTD. - 812 CLOVERDALE
- ⑦ VINYL WINDOWS - CHARCOAL EXTERIOR, WHITE INTERIOR
- ⑧ GUARDRAIL WITH TEMPLERED GLASS + PRE-FINISHED METAL - CHARCOAL
- ⑨ GUARD RAIL WITH PRE-FINISHED METAL - CHARCOAL
- ⑩ FIBREGASS DOOR W/ SIDE LITE - PTD. TO MATCH WINDOWS
- ⑪ FIBREGASS DOOR W/ FULL LITE - PTD. TO MATCH WINDOWS
- ⑫ VINYL SLIDING DOOR UNITS - CHARCOAL EXTERIOR, WHITE INTERIOR
- ⑬ METAL SOFFIT - WOOD-GRAIN VALNUT OR BROWN TO MATCH CLADDING
- ⑭ 2-PLY SSS ROOFING - CHARCOAL GREY
- ⑮ WOOD SCREENS + TRELLISES - 811 CLOVERDALE

**MATERIAL FINISHES**

RECEIVED  
 DP 1111  
 2019-MAR-05  
 CIVIL ENGINEERING





macdonald gray  
814 Sherwood Drive, Parkville, BC, V0P 1S1  
TEL: (250) 248-3099 FAX: (250) 248-3099  
www.macdonaldgray.ca

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# 615 & 699 Harewood Road 1035137 BC Ltd. Nanaimo, BC

**PLANTING PLAN**  
 Date: February 22, 2019  
 Drawn: CM  
 Checked: MG  
 Project Number: 18-0204  
 Scale: 1:200 metric  
 L2 of 4  
 DRAWING NUMBER:

#	DATE	NOTES
1	2019/FEB/20	Issued for DR
2	2019/FEB/20	Revised for DR



### PLANTING NOTES

- ALL LANDSCAPE INSTALLATION AND MAINTENANCE SHALL MEET OR EXCEED THE MOST RECENT STANDARDS SET OUT BY THE CANADIAN LANDSCAPE NURSERY ASSOCIATION (CLNA) / CANADIAN SOCIETY OF LANDSCAPE ARCHITECTS (CSLA) CANADIAN LANDSCAPE STANDARD.
- ALL TREES SHALL BE PLANTED WITH 300mm OF TOPSOIL OR AMENDED ORGANIC SOILS AROUND AND BELOW FOOTBALL.
- SOIL DEPTHS:  
 SHRUBS - 450mm  
 LARVA AND CREEPER FRANKING: 300mm  
 TREES - 300mm AROUND AND BELOW FOOTBALL
- MULCH SHALL BE COMPOST PER SECTION 10. MULCHING OF THE BENTON DSUSA BC LANDSCAPE STANDARD. MULCH DEPTH SHALL BE 75mm MINIMUM OVER ALL TREE AND SHRUB PLANTING AREAS.
- PLANT MATERIAL QUALITY, TRANSPORT AND HANDLING SHALL COMPLY WITH BCNPA BCSLA STANDARDS FOR NURSERY STOCK.
- ALL PLANTING AREAS SHALL BE WATERED VIA AN UNDERGROUND AUTOMATIC IRRIGATION SYSTEM. IRRIGATION EMISSION DEVICES SHALL BE LOW VOLUME ROTARY NOZZLES OR MICRO DRIP EQUIPMENT.
- PLANT QUANTITIES ARE FOR INFORMATION ONLY. IN CASE OF ANY DISCREPANCY THE PLAN SHALL GOVERN.
- ALL PLANT MATERIAL SHALL MATCH SPECIES AS INDICATED ON THE PLANTING LEGEND.
- CONTACT THE LANDSCAPE ARCHITECT FOR APPROVAL OF ANY SUBSTITUTIONS. NO SUBSTITUTIONS WILL BE ACCEPTED WITHOUT PRIOR WRITTEN APPROVAL OF THE LANDSCAPE ARCHITECT.
- CHECK FOR LOCATIONS OF WATER LINES AND OTHER UNDERGROUND SERVICES PRIOR TO DIGGING TREE PITS. VERIFY THE DEPTH OF ALL SERVICES. IF ANY PITS ARE FULLY FLOODED WITH WATER SHALL DRAIN WITHIN ONE HOUR AFTER FILLING.
- NO BRANCHES REQUIRING PRUNING OF MAJOR BRANCHES DUE TO DISEASE, DAMAGE OR POOR FORM WILL BE ACCEPTED.
- ALL CALIPRE STOCK TREES SHALL BE B & B IN WIRE BASKETS.

### PLANT LEGEND

SYMBOL	BOTANICAL / COMMON NAME	SIZE	SPACING	QTY.	NOTES
	ACER GINONATUM VINE MAPLE	#5 POT	SEE PLAN	10	NATIVE SPECIES
	ERICIS CANADENSIS FOREST PANSY FOREST PANSY LACTARIUM REDBUD	6cm CAL	1.0m O.C.	3	NATIVE CANADIAN CULTIVAR
	CORULUS CORNUTA BEAKED HAZELNUT	6cm CAL	2.0m O.C.	13	NATIVE SPECIES, (1) REPLACEMENT TREE
	FAGUS SYLVATICA 'DAWKOCK' GOLD COLUMBARK-GOLDEN BEECH	5cm CAL	SEE PLAN	7	DROUGHT TOLERANT
	GLIEDERA TRIACANTOS VAR. INENSIS SIMOLE SHURBUBIST HONEY LOCUST	5cm CAL	SEE PLAN	3	DROUGHT TOLERANT
	MAULUS 'GOLDEN RAINBOWS' CRABAPPLE GOLDEN RAINBOWS CRABAPPLE	6cm CAL	6.0m O.C.	6	NATIVE CULTIVAR, STREET TREE UNDER NEAR OVERHEAD WIRES
	PSUDOTSUGA MENZIESII DOUGLAS FIR	2.0m	SEE PLAN	9	NATIVE SPECIES, REPLACEMENT TREES
	TILIA CORDATA GREENSPRUE GREENSPRUE LINDEN	5cm CAL	SEE PLAN	2	DROUGHT TOLERANT
	BERBERIS THUNBERGII 'CONCORD' CONCORDE JAPANESE BARBERRY	#2 POT	1.0m O.C.	84	DROUGHT TOLERANT
	CHRYSA TERNA MEXICAN ORANGE	#1 POT	1.0m O.C.	28	DROUGHT TOLERANT
	COTINUS COCCINEA 'N. COCT.' GOLDEN SPIRIT SMOKE BUSH	#5 POT	SEE PLAN	6	DROUGHT TOLERANT
	ILEX CEMATA 'CONWAY' JAPANESE HOLLY	#1 POT	1.0m O.C.	24	DROUGHT TOLERANT, LOW HEDGE
	JUNIPERUS SABINA 'TAMARISCIFOLIA' TAMARISK JUNIPER	#2 POT	1.0m O.C.	37	DROUGHT TOLERANT
	JUNIPERUS SCOPULORUM 'WICHTA BLUE' WICHTA BLUE JUNIPER	#5 POT	SEE PLAN	3	DROUGHT TOLERANT
	LOINCERA NITIDA 'LINDEN BEAUTY' LINDEN BEAUTY BOX HONEYSUCKLE	#1 POT	1.2m O.C.	49	DROUGHT TOLERANT
	MAHONIA AQUILIFORMIS OREGON GRAPE	#2 POT	1.0m O.C.	54	NATIVE SPECIES, DROUGHT TOLERANT
	POUSTICHIUM MUNITUM SWORD FERN	#2 POT	1.0m O.C.	51	NATIVE SPECIES
	FRANUS LAUROCARPUS OTTO LUYVEN DWARF ENGLISH LAUREL	#2 POT	1.0m O.C.	16	DROUGHT TOLERANT, LOW HEDGE
	RHOODODENDRON SSP. MIX RED & WHITE	#5 POT	SEE PLAN	22	DROUGHT TOLERANT
	THUJA PLICATA 'EXCELSA' EXCELSA RED CEDAR	1.5m	0.9m O.C.	42	NATIVE CULTIVAR, 1.5m HEDGE
	VIOLARIUM DAVIDII DAVIDS VIBURNUM	#1 POT	1.0m O.C.	45	DROUGHT TOLERANT
	GROUNDCOVER, VINDS & PERENNIALS	PLUG	0.6m O.C.	200	NATIVE SPECIES
	CAREX OBLONGIFOLIA DWARF SWAMP SEDGE	#1 POT	1 PER POST	3	VINE ON POST TOP ABOVE
	CLEMATIS MANJARIANA BURGUNDIAN GLAZIUS	#1 POT	0.6m O.C.	130	NATIVE CULTIVAR
	CORNUS STOLONIFERA DWARF DOGWOOD	1.0m POT	0.45m O.C.	195	DROUGHT TOLERANT
	ELONIA ALBOVARIA 'VICK RADICANS' HAREWOOD FRONTAGE CHERRY	#1 POT	0.5m O.C.	85	DROUGHT TOLERANT
	MAHONIA LAURATA 'VIRESCENS' GOLDEN JAPANESE FOREST GRASS	#2 POT	0.6m O.C.	41	SHADE TOLERANT
	JUNO B. SPENSIS COMMON RUSH	PLUG	0.6m O.C.	150	NATIVE SPECIES
	MAHONIA LAURATA 'VIRESCENS' GOLDEN JAPANESE FOREST GRASS	1.0m POT	0.45m O.C.	95	NATIVE SPECIES
	PERNASTEMUM ALBERTIENSES 'WAMELEY DWARF FOUNTAIN GRASS	#2 POT	0.6m O.C.	113	DROUGHT TOLERANT
	LAWN	500	75m <sup>2</sup>		

NOTE: DROUGHT TOLERANCE IS BASED ON SPECIES ONCE ESTABLISHED

RECEIVED  
 DP 1115  
 2019-FEB-28  
 CURTAIN PLANTING



macdonald gray  
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 Nanaimo, BC  
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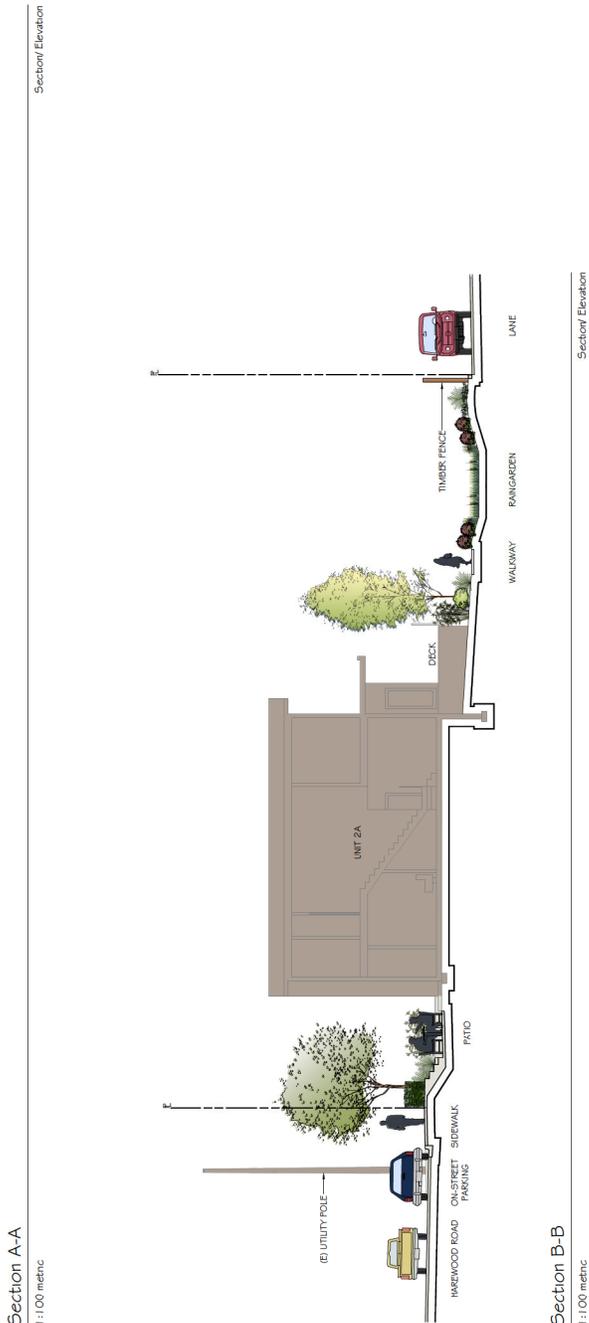
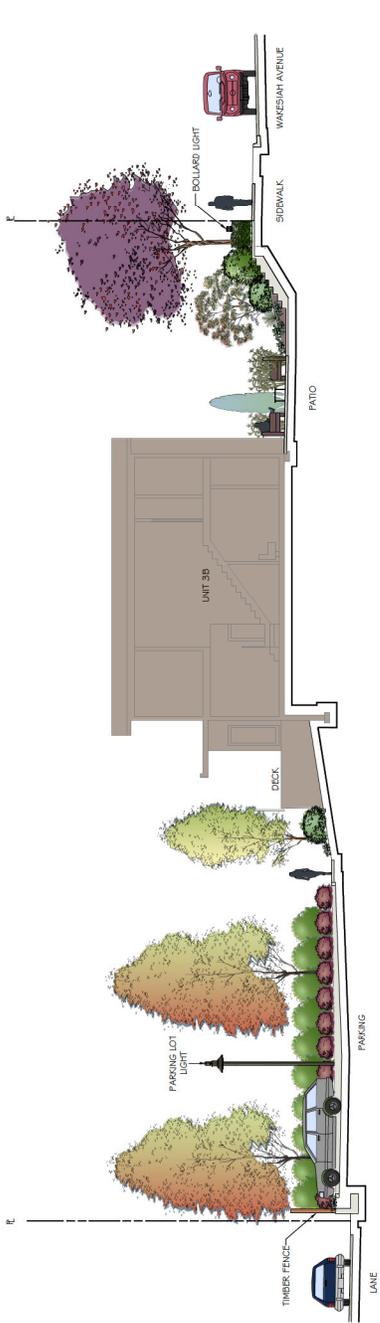
**SECTIONS**

DRAWING NUMBER: L3 of 4  
 Project Number: 18-0204  
 Scale: 1:100 metric  
 Checked: HG  
 Drawn: CA  
 Date: February 22, 2019

#	Date	NOTES
0	20JUN2018	IP Review & Coordination
1	06SEP2018	Issued for IP
2	27FEB2019	Revised for IP

REVISION SCHEDULE

RECEIVED  
 DP 1115  
 2019-FEB-28  
 CIBC FIRST





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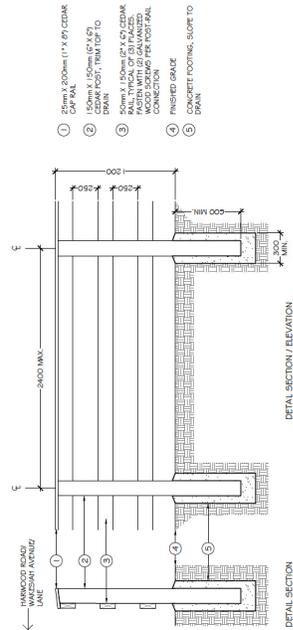
615 & 699 Harewood Road  
 1035137 BC Ltd.  
 Nanaimo, BC

DRAWING NUMBER: L4 of 4	
Project Number: 18-0204	Scale: AS NOTED
Checked: HG	Drawn: CJA
Date: February 27, 2019	Revision Schedule

#	Date	Notes
0	20/JAN/2018	IP Review & Coordination
1	06/FEB/2018	Issued for IP
2	27/FEB/2019	Revised for IP




COLLIERY DAM INSPIRATION



- 1 25mm x 200mm (1" x 8") CEDAR CAP RAIL
- 2 150mm x 150mm (6" x 6") DRUM POST - 1000 TOP TO
- 3 50mm x 150mm (2" x 6") CEDAR RAIL WITH (2) GALVANIZED BOLTS FOR POST RAIL CONNECTION
- 4 FINISHED GRADE
- 5 CONCRETE FOOTING, SLOPE TO DRAIN


DETAIL SECTION / ELEVATION  
 1:25 metric

**B** Colliery Dam Fence  
 Section Elevation

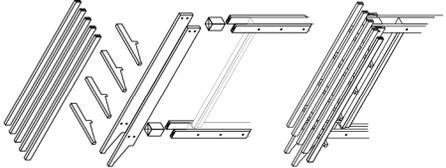

FREE STANDING 4 POST TOP ARBOR SCHEMATIC NOT TO SCALE

- 1 50mm x 150mm (2" x 6") CEDAR RAIL
- 2 150mm x 150mm (6" x 6") POST
- 3 25mm x 100mm (1" x 4") FINISH RAIL, TYPICAL OF (B)
- 4 50mm x 100mm (2" x 4") FINISH RAIL, TYPICAL OF (B)
- 5 50mm x 100mm (2" x 4") FINISH RAIL, TYPICAL OF (B)
- 6 CONCRETE FOOTING, SLOPE TO DRAIN

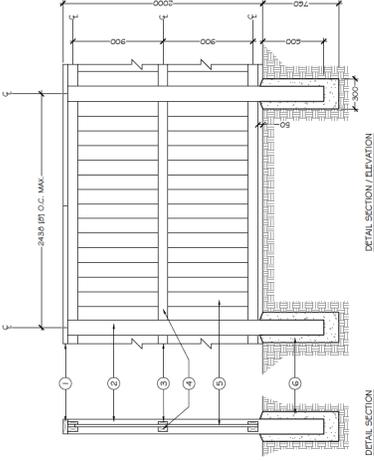

DETAIL SECTION / ELEVATION  
 1:25 metric

**A** 2.0m Fence, Post Top & Freestanding Arbor  
 Section Elevation/ Isometric

RECEIVED  
 DP 1115  
 2019-FEB-28  
 COURTNEY PATRICKS

# ATTACHMENT F STREETSCAPES



STREETSCAPE ALONG HAREWOOD ROAD



STREETSCAPE ALONG WAKESIAH AVENUE



SITE PLAN



STREETSCAPE ALONG LANEWAY

ATTACHMENT G  
AERIAL PHOTO



DEVELOPMENT PERMIT NO. DP001115